



AYDEN-GRIFTON HIGH SCHOOL NATURAL GAS MAIN EXTENSION




Gas Engineering 3355 NC 43 N Greenville, NC 27834




INDEX

Sheet C1: STA 0+00 - STA 13+35 Sheet C2: STA 13+35 - STA 28+50 Sheet C3: STA 28+50 - STA 44+00 Sheet C4: STA 44+00 - STA 57+80 Sheet D1: Traffic Control Details Sheet D2: Erosion Control & Misc. Details Sheet D3: Misc. Details

LEGEND

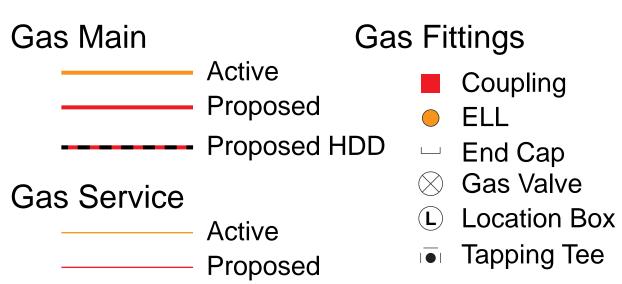

Features

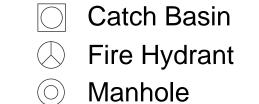


S/L Signal Light Cabinet


Telephone Pedestal


Utility Pole


w Water Valve


Abandoned Gas Main

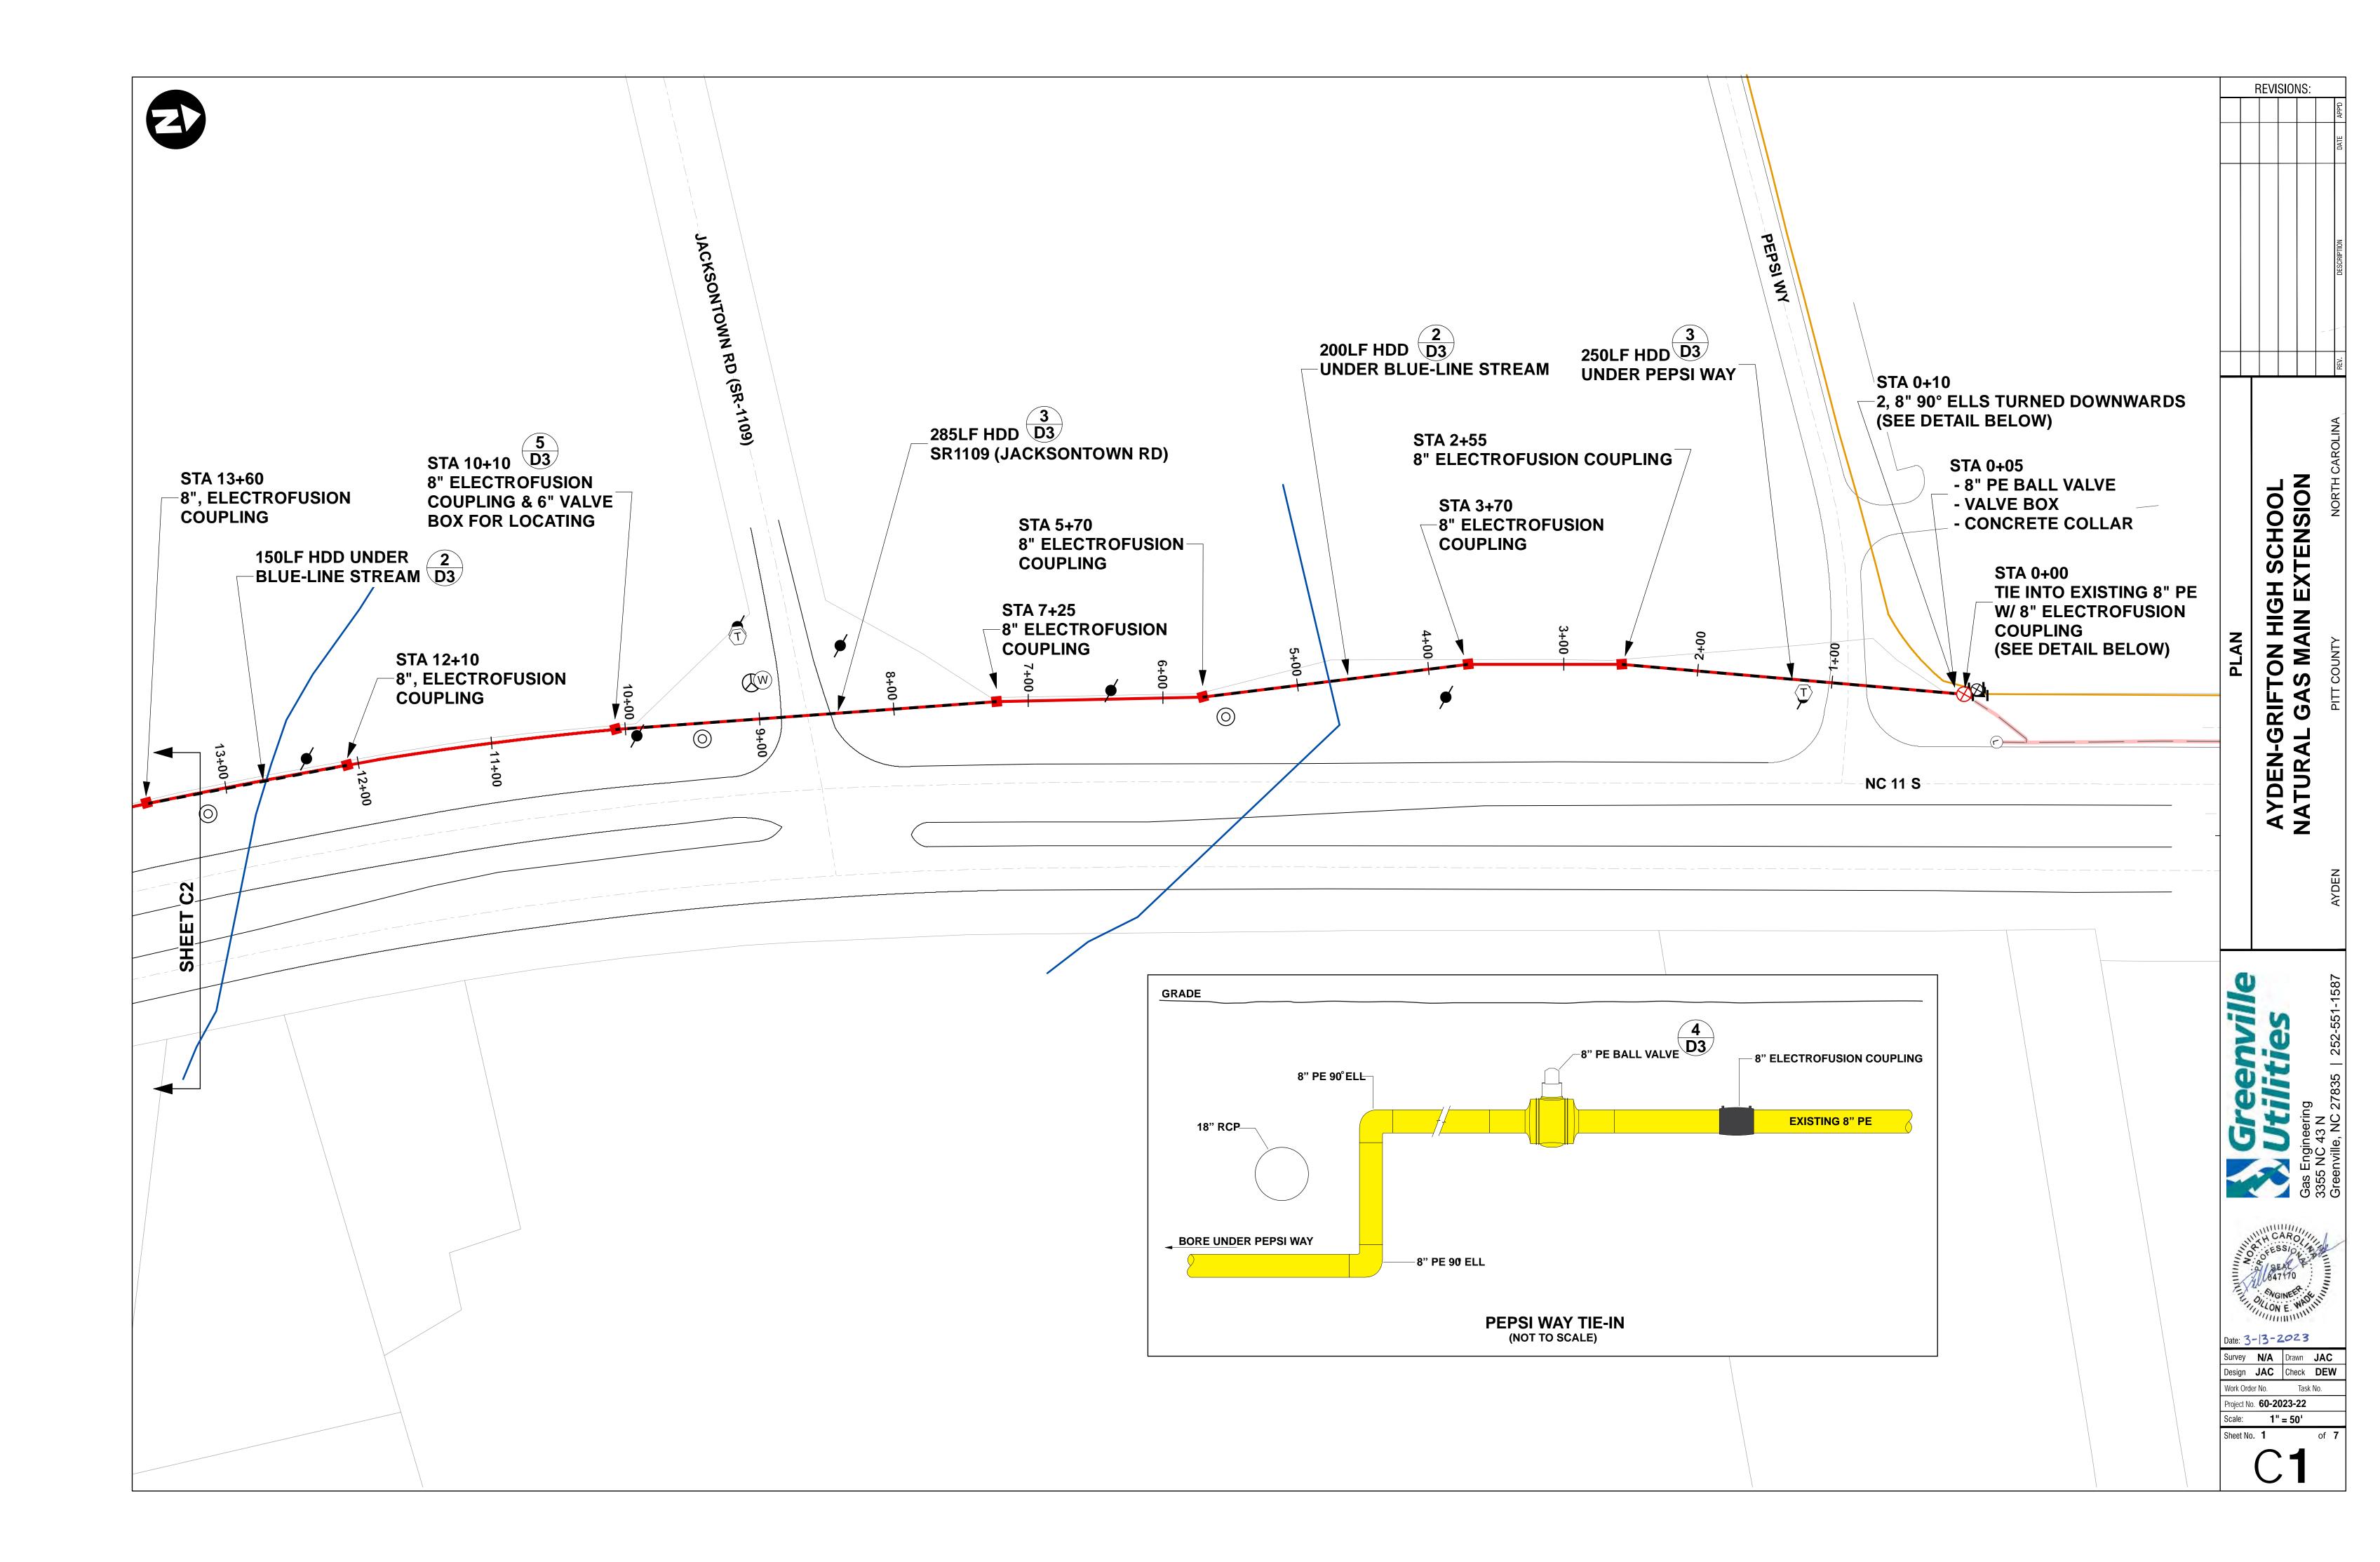

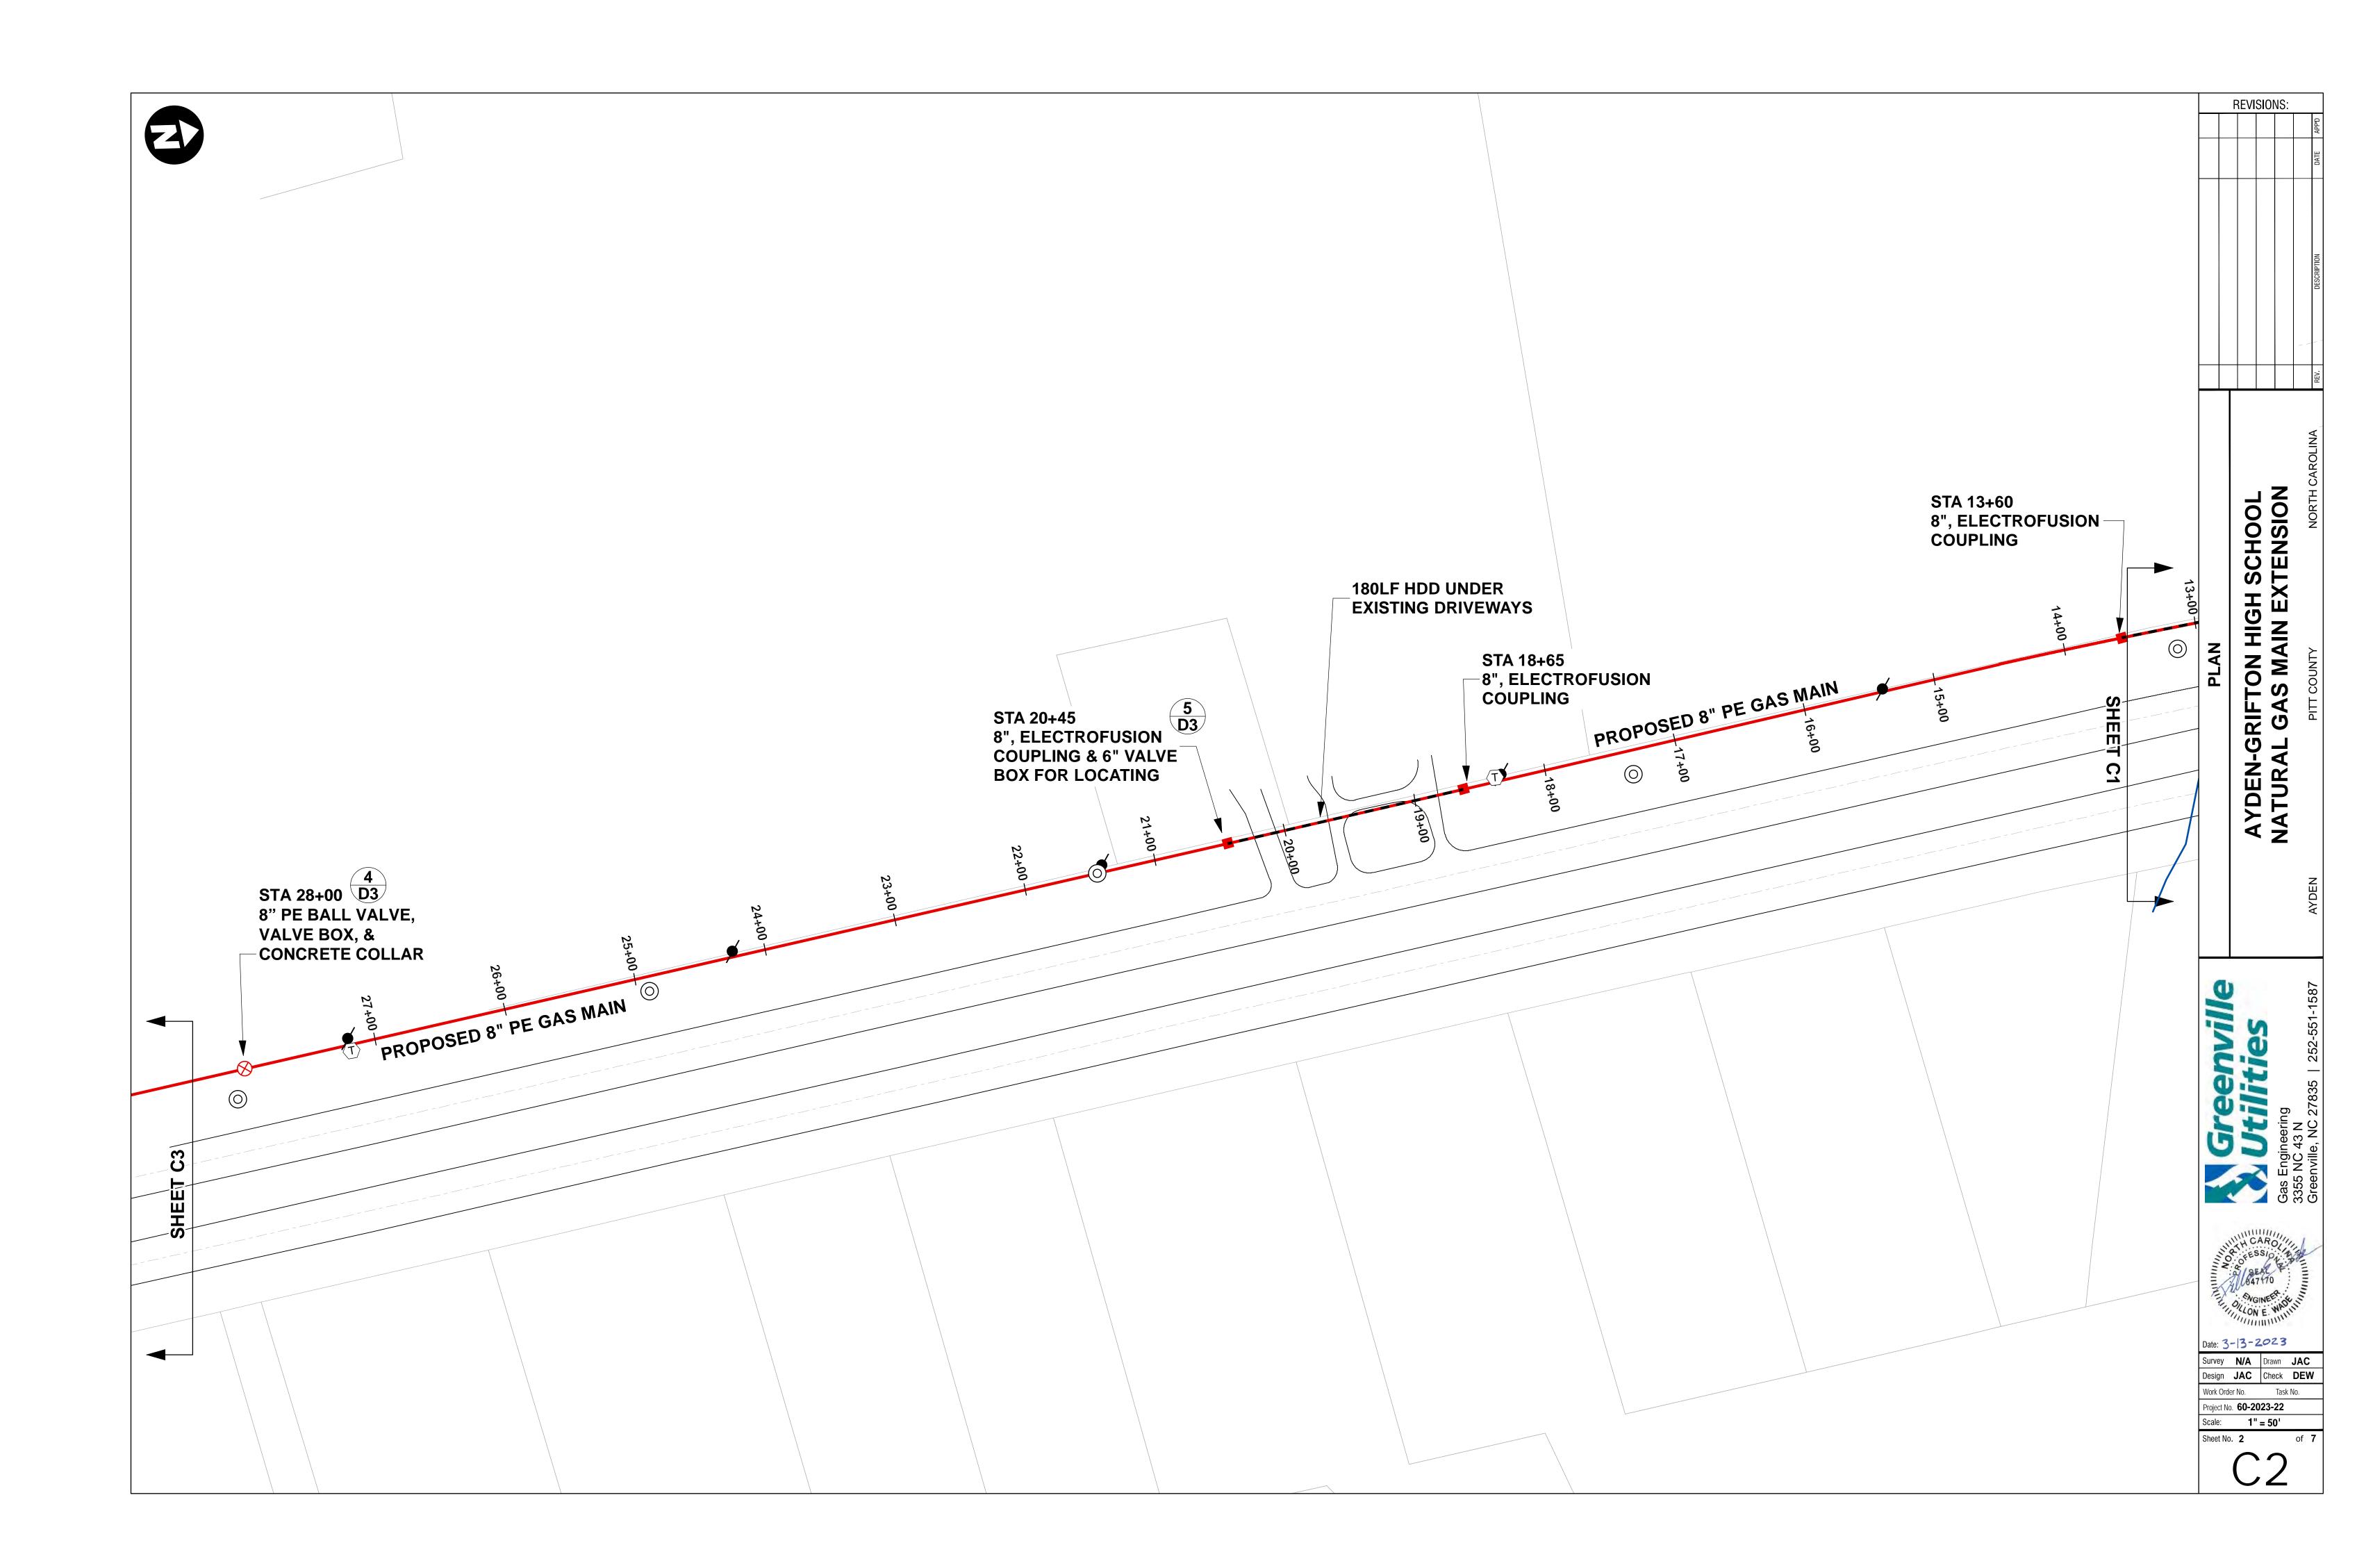

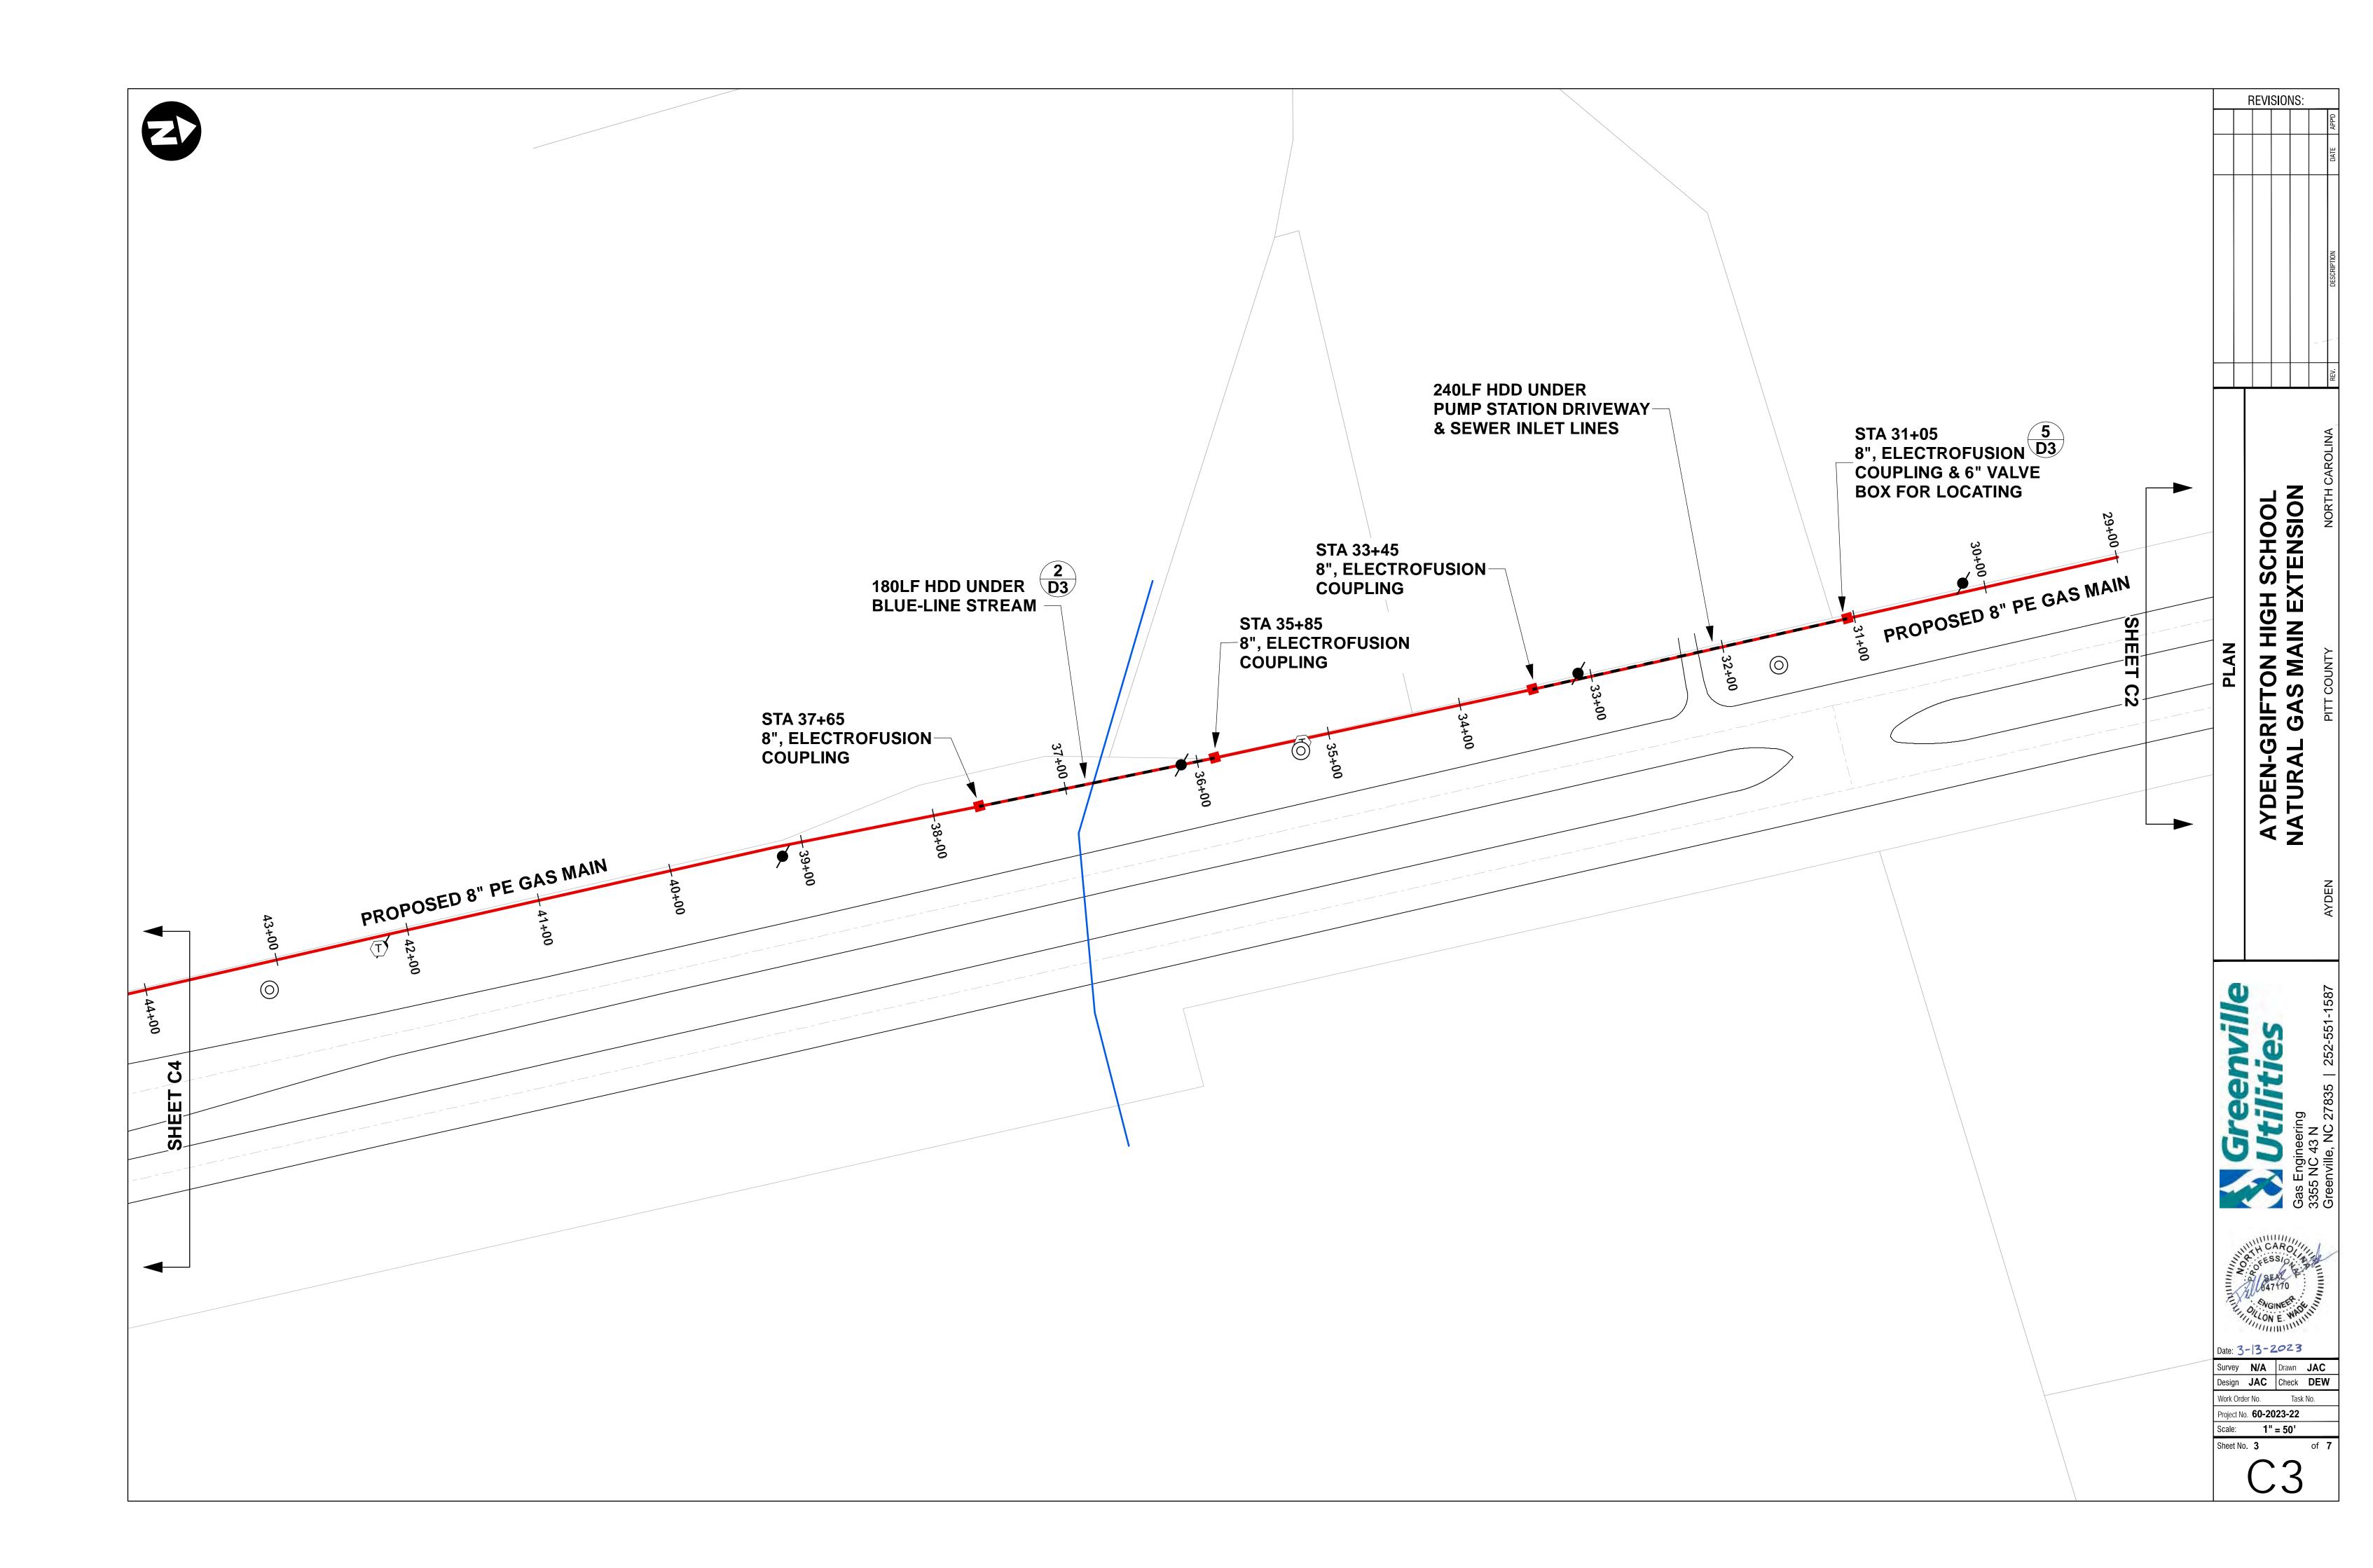

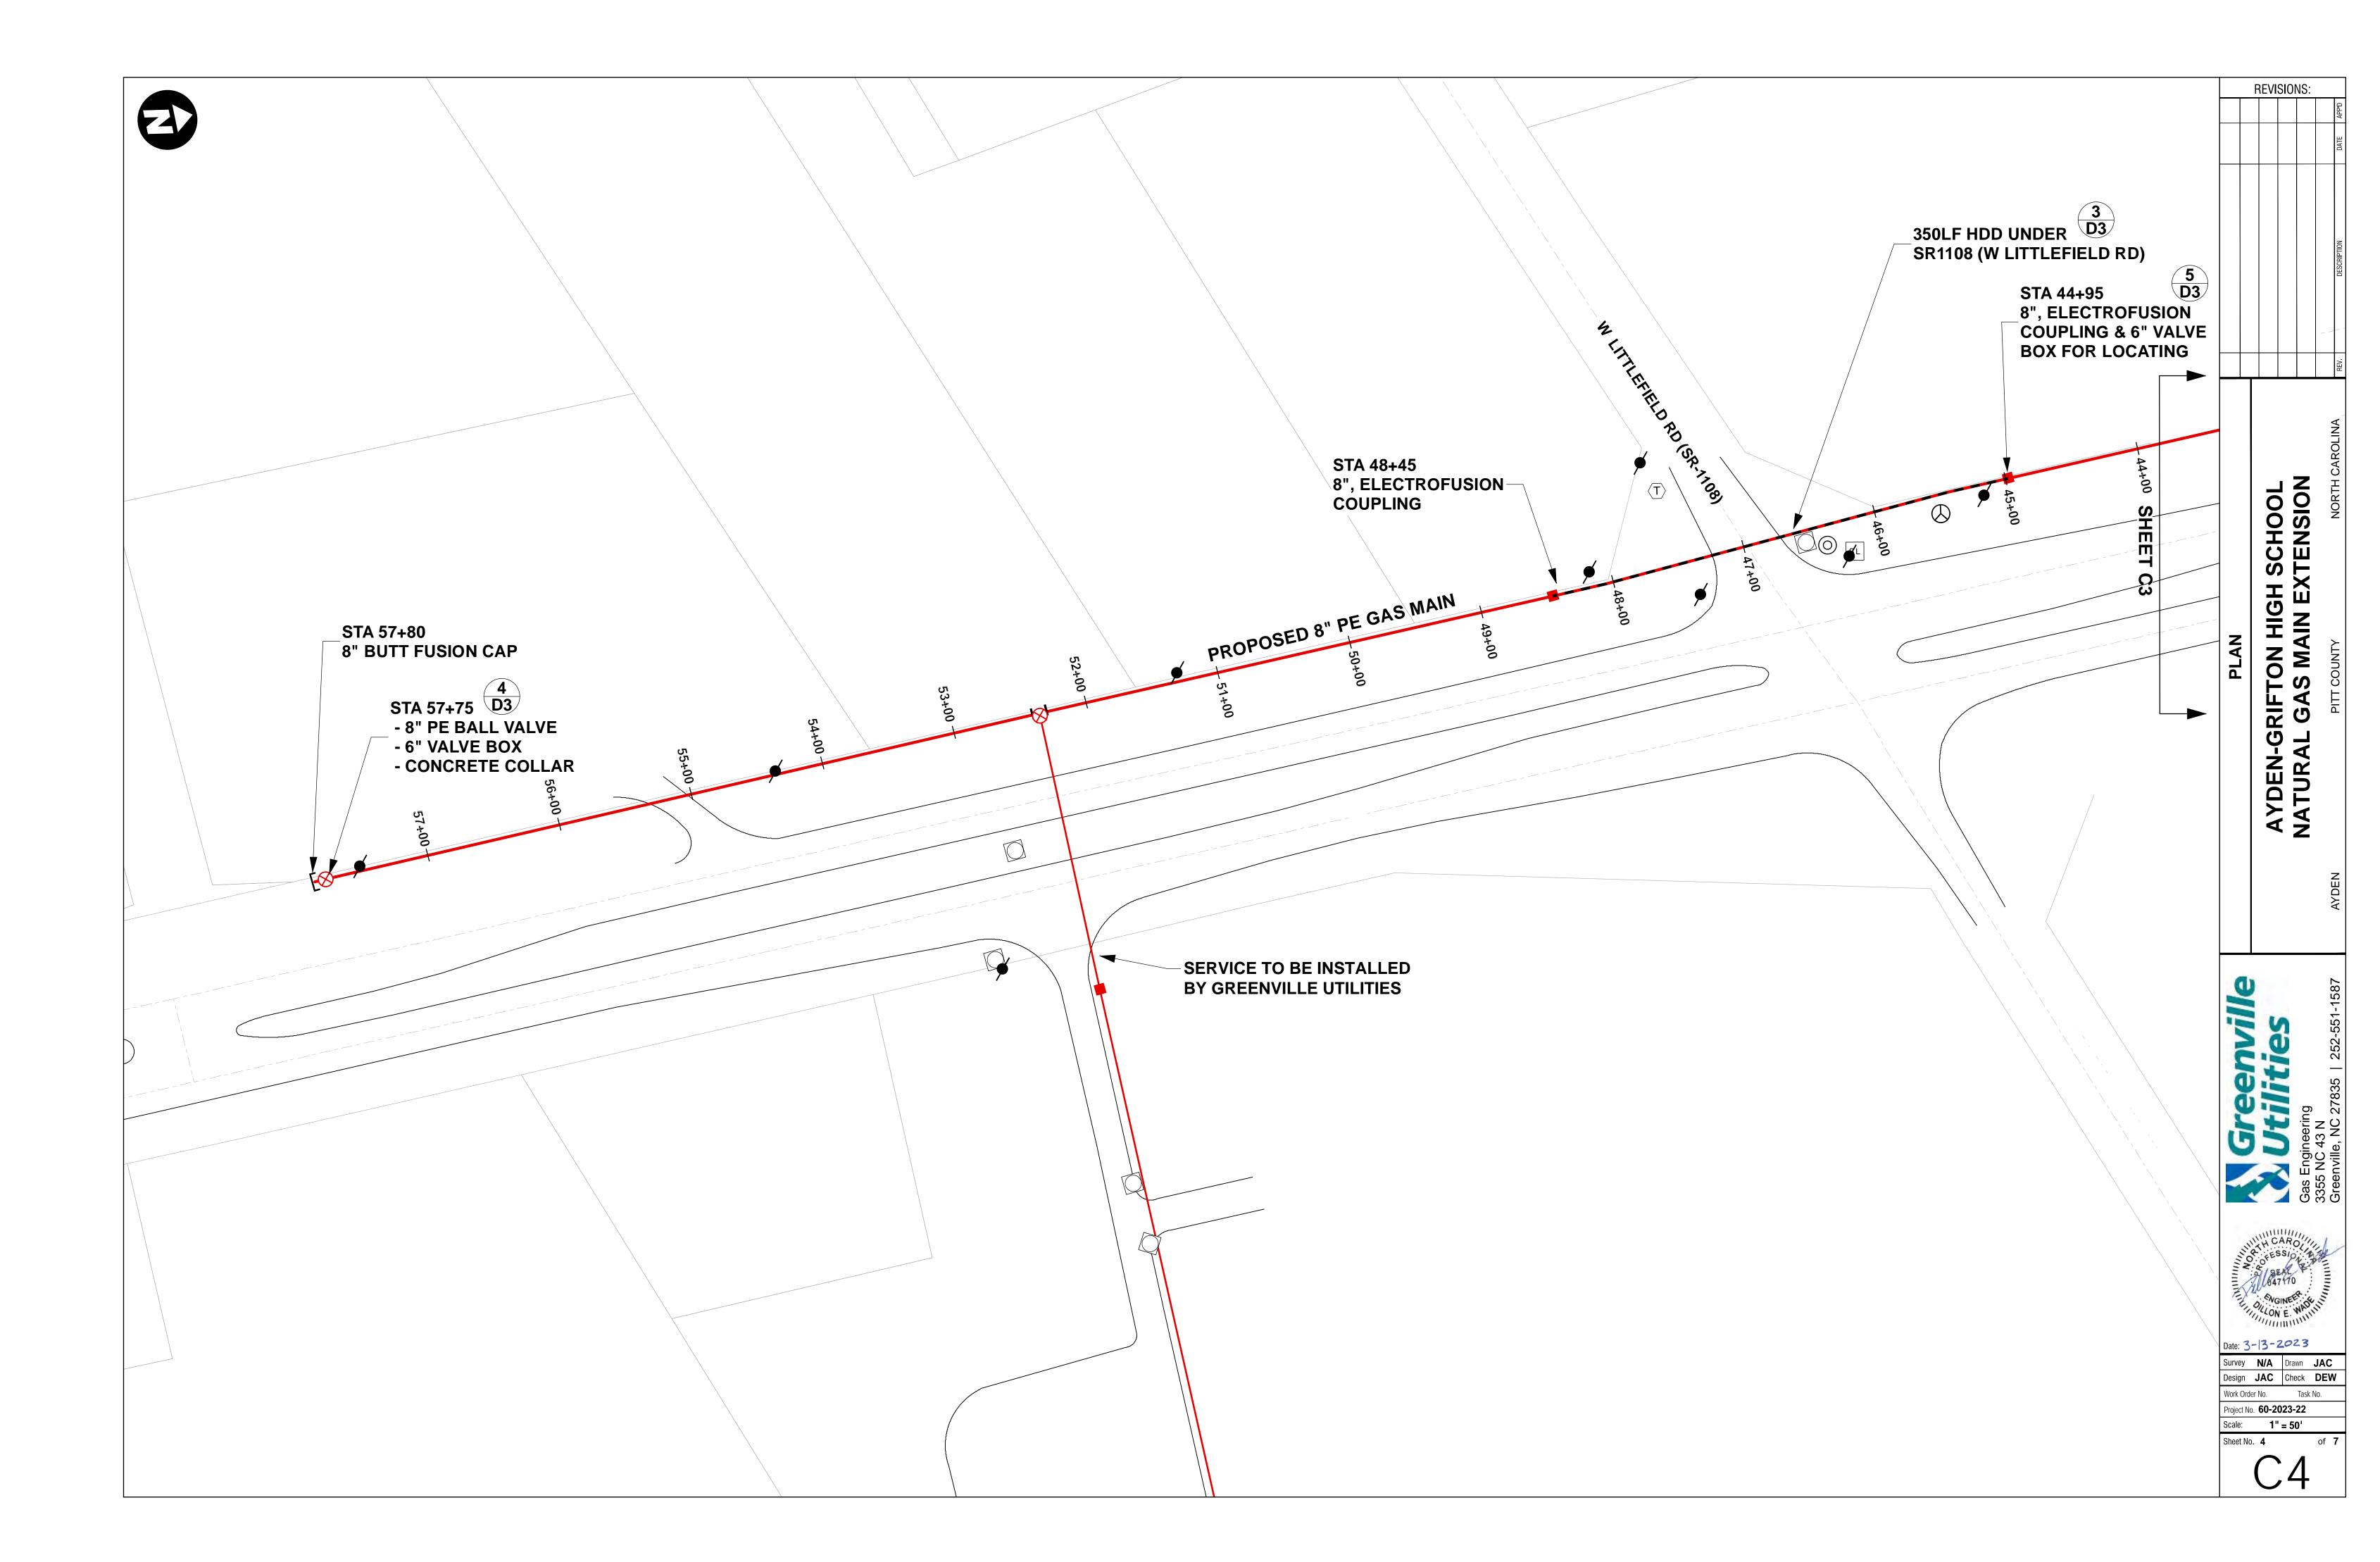

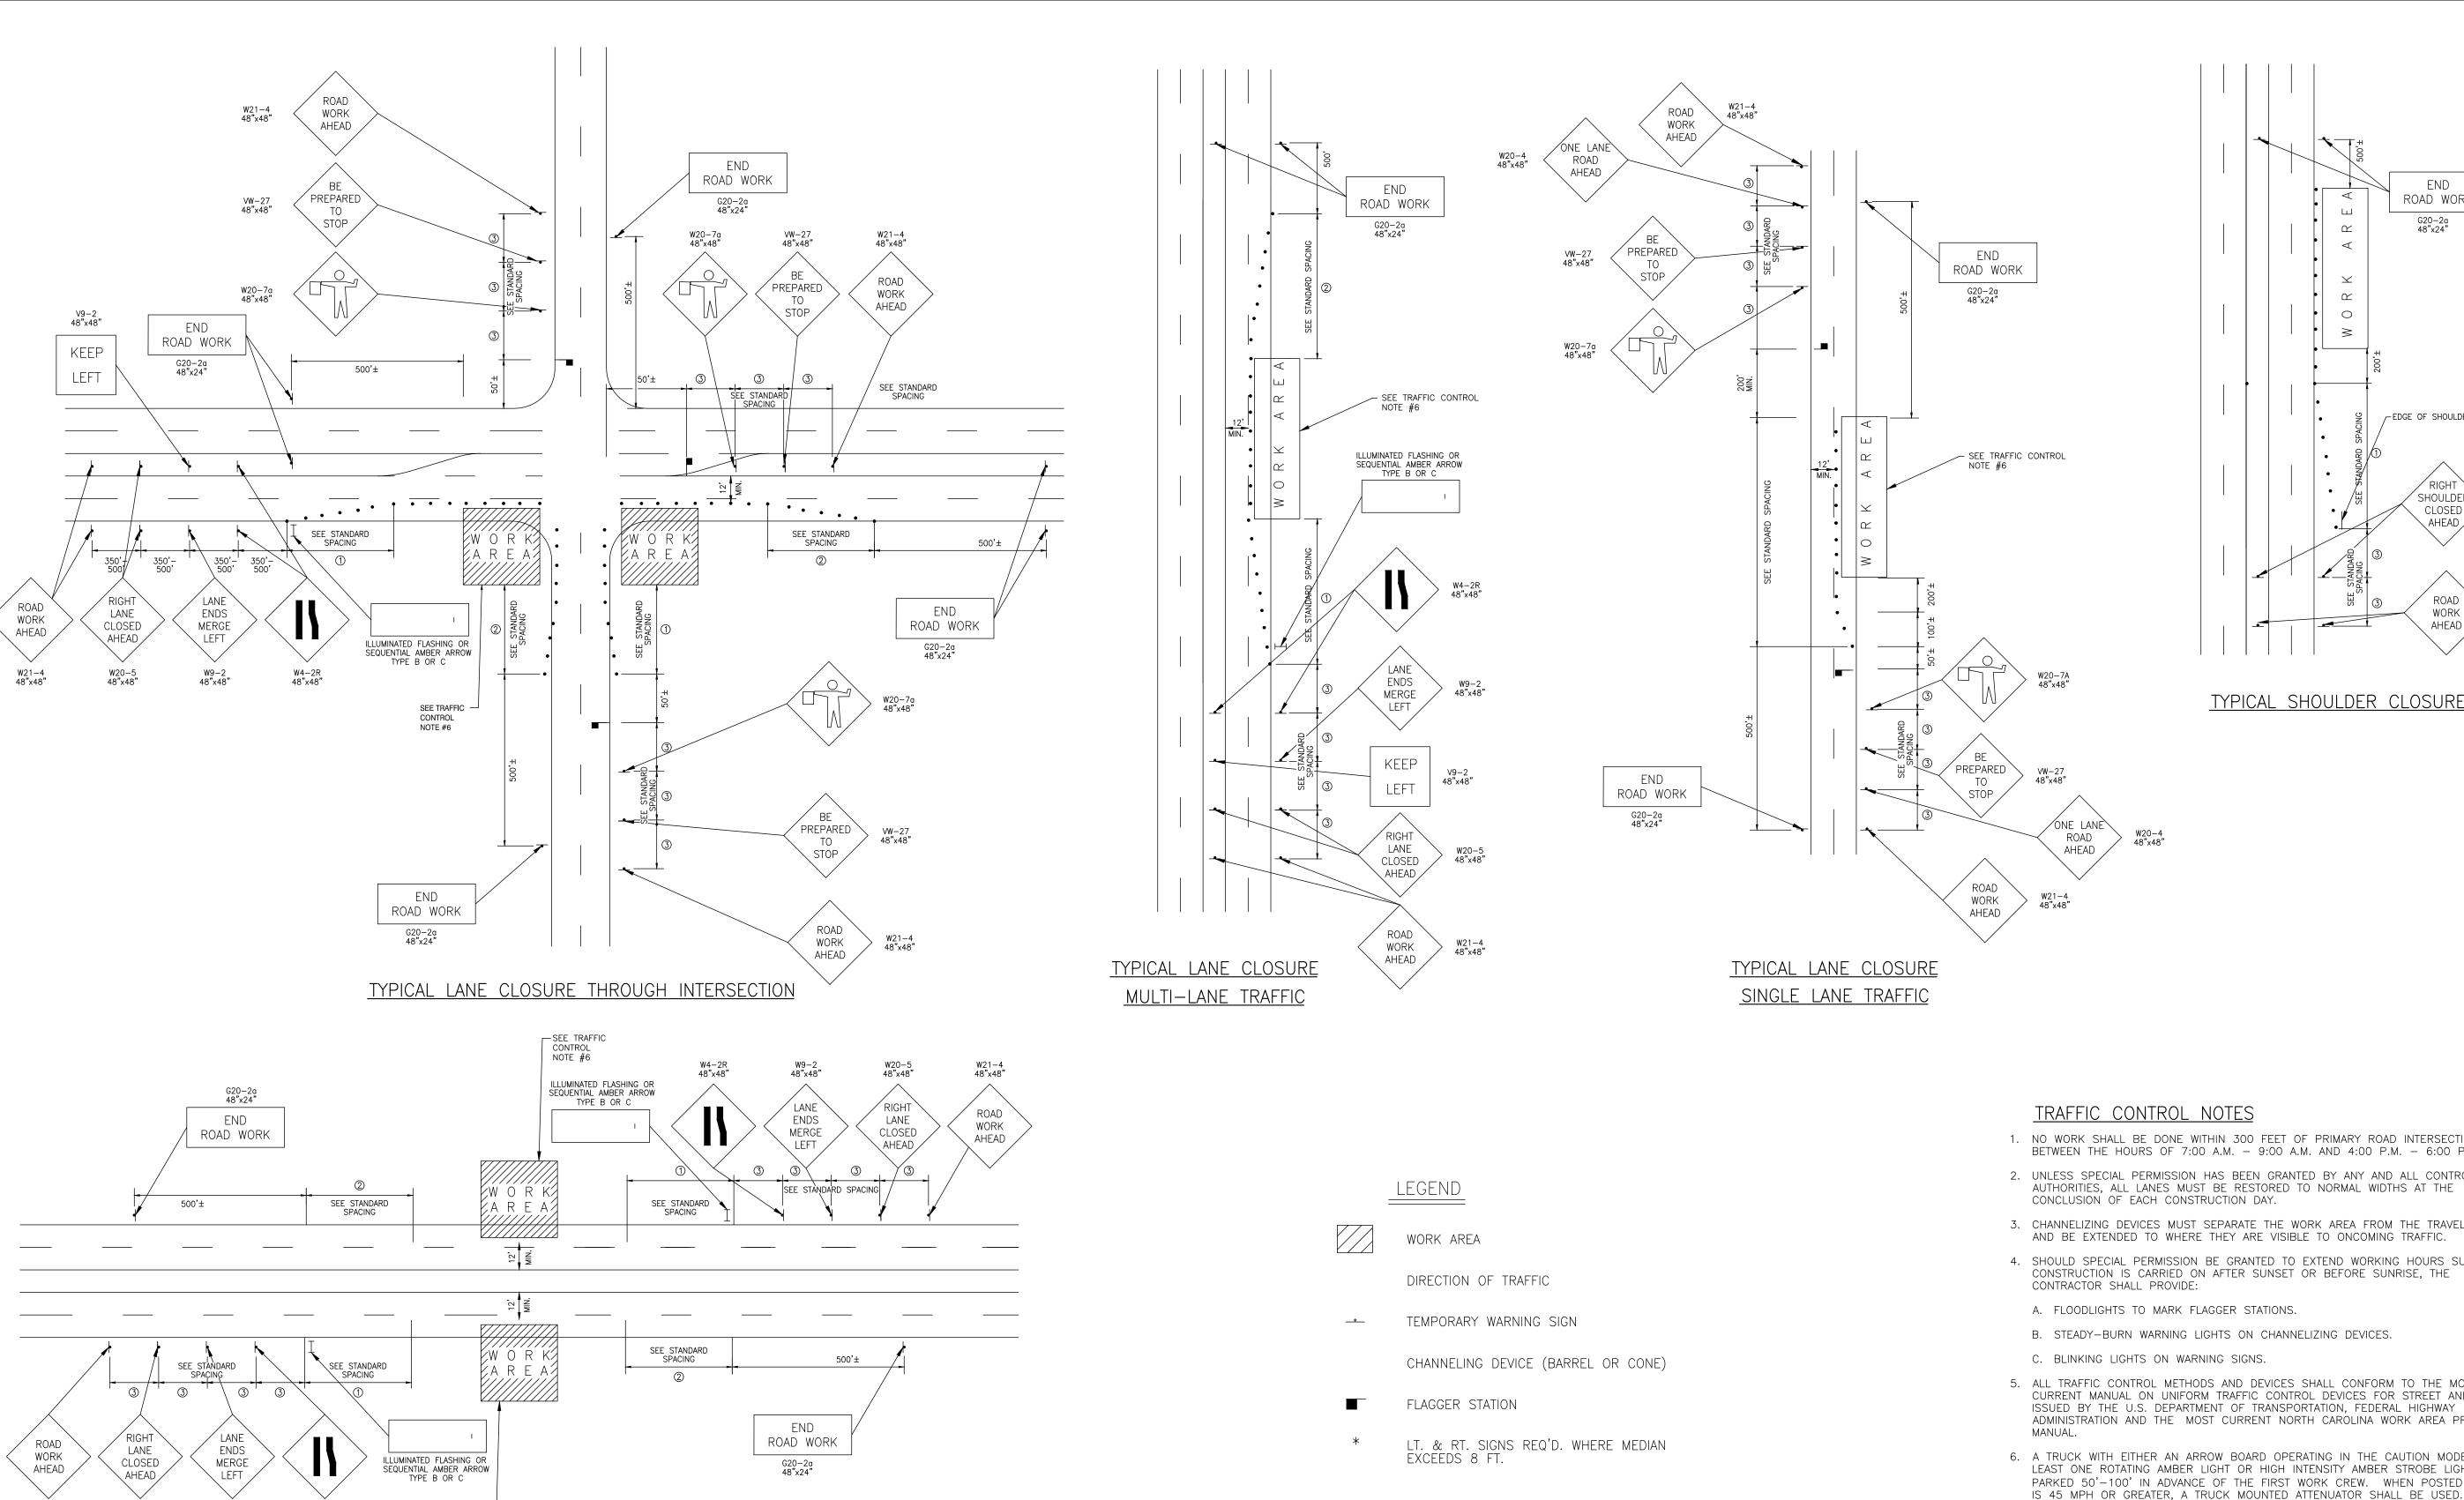

TYPICAL BORE ACROSS ROAD

STANDARD SPACING

35 MPH 45 MPH

350'-500' | 350'-500'

20'

245'

80'

80'

40'

540'

80'

SPACE TYPE

(1) ENTRANCE TAPER

(2) EXIT TAPER

(3) SIGN SPACING

BARRELS - TRAVELWAY SPACING

BARRELS - TRAVELWAY SPACING

- 1. NO WORK SHALL BE DONE WITHIN 300 FEET OF PRIMARY ROAD INTERSECTIONS BETWEEN THE HOURS OF 7:00 A.M. - 9:00 A.M. AND 4:00 P.M. - 6:00 P.M.
- 2. UNLESS SPECIAL PERMISSION HAS BEEN GRANTED BY ANY AND ALL CONTROLLING AUTHORITIES, ALL LANES MUST BE RESTORED TO NORMAL WIDTHS AT THE
- 3. CHANNELIZING DEVICES MUST SEPARATE THE WORK AREA FROM THE TRAVELED WAY AND BE EXTENDED TO WHERE THEY ARE VISIBLE TO ONCOMING TRAFFIC.
- 4. SHOULD SPECIAL PERMISSION BE GRANTED TO EXTEND WORKING HOURS SUCH THAT CONSTRUCTION IS CARRIED ON AFTER SUNSET OR BEFORE SUNRISE, THE
 - A. FLOODLIGHTS TO MARK FLAGGER STATIONS.
- B. STEADY-BURN WARNING LIGHTS ON CHANNELIZING DEVICES.
- 5. ALL TRAFFIC CONTROL METHODS AND DEVICES SHALL CONFORM TO THE MOST CURRENT MANUAL ON UNIFORM TRAFFIC CONTROL DEVICES FOR STREET AND HIGHWAYS ISSUED BY THE U.S. DEPARTMENT OF TRANSPORTATION, FEDERAL HIGHWAY ADMINISTRATION AND THE MOST CURRENT NORTH CAROLINA WORK AREA PROTECTION
- 6. A TRUCK WITH EITHER AN ARROW BOARD OPERATING IN THE CAUTION MODE, OR AT LEAST ONE ROTATING AMBER LIGHT OR HIGH INTENSITY AMBER STROBE LIGHT SHALL BE PARKED 50'-100' IN ADVANCE OF THE FIRST WORK CREW. WHEN POSTED SPEED LIMIT IS 45 MPH OR GREATER, A TRUCK MOUNTED ATTENUATOR SHALL BE USED.
- 7. THE CONTRACTOR IS RESPONSIBLE FOR REPLACEMENT OF ANY PAVEMENT MARKINGS DAMAGED BY CONSTRUCTION.
- 8. ACCESS TO ALL PARCELS AFFECTED BY CONSTRUCTION SHALL BE MAINTAINED AT ALL
- 9. THE CONTRACTOR SHALL OBTAIN WRITTEN CONSENT FROM THE CONTROLLING AUTHORITY PRIOR TO CLOSING ONE LANE OF A TWO LANE ROADWAY.
- 10. THIS PLAN IS PROVIDED BY GREENVILLE UTILITIES COMMISSION IN AN EFFORT TO PROVIDE THE CONTRACTOR WITH AN UNDERSTANDING OF THE MINIMUM REQUIREMENTS FOR TRAFFIC CONTROL WHICH MUST BE MET AND TO AID IN THE INCLUSION OF THOSE COSTS IN THE PREPARATION OF HIS BID. THIS PLAN AND THE USE THEREOF DOES NOT IN ANY WAY RELIEVE THE CONTRACTOR OF HIS RESPONSIBILITIES OF PROTECTION OF THE WORK AND THE PUBLIC'S SAFETY. IT IS A SPECIFIC CONTRACT REQUIREMENT THAT THE CONTRACTOR INDEMNIFY AND HOLD HARMLESS THE OWNER AND THE ENGINEER AGAINST ALL LOSSES INCURRED IN THE EXECUTION OF THE WORK AND IN THE GUARDING OF IT. THIS REQUIREMENT INCLUDES BUT IS NOT LIMITED TO THE USE OF THIS PLAN.

YDEN-GRIFTON HIGH SCHOOL ATURAL GAS MAIN EXTENSION


₹Ž

REVISIONS:

END ROAD WORK

RIGHT SHOULDER CLOSED AHEAD

ROAD WORK AHEAD

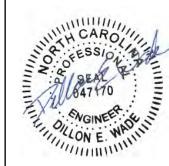

Date: 3-13-2023

Survey **N/A** Drawn **JAC** Design **JAC** Check **DEW** Work Order No. Task No. Project No. **60-2023-22**

Scale: 1" = 50' Sheet No. 5

CONSTRUCTION SPECIFICATIONS <u>MAINTENANCE</u> SYNTHETIC FILTER FABRIC SHALL BE A PERVIOUS SHEET PROPYLENE, NYLON, 1. SILT FENCES SHALL BE INSPECTED IMMEDIATELY AFTER EACH RAINFALL POLYESTER OR ETHYLENE YARN AND SHALL BE CERTIFIED BY THE AND AT LEAST DAILY DURING PROLONGED RAINFALL. ANY REQUIRED MANUFACTURER OR SUPPLIER AS CONFORMING TO THE FOLLOWING REPAIRS SHALL BE MADE IMMEDIATELY. **REQUIREMENTS:** 2. CLOSE ATTENTION SHALL BE PAID TO THE REPAIR OF DAMAGED SILT PHYSICAL PROPERTY **REQUIREMENTS** FENCE RESULTING FROM END RUNS AND UNDERCUTTING. FILTERING EFFICIENCY ASTM 5141 85% (MIN.) 3. SHOULD THE FABRIC ON A SILT FENCE DECOMPOSE OR BECOME TENSIĻE STRENGTH AT VTM-52 EXTRA STRENGTH-INEFFECTIVE PRIOR TO THE END OF THE EXPECTED USABLE LIFE AND 20% (MAX.) ELONGATION 50 LBS./LIN.IN. (MIN.) THE BARRIER STILL BE NECESSARY, THE FABRIC SHALL BE REPLACED ASTM 5141 0.3 GAL./SQ.FT./MIN. (MIN.) SEDIMENT DEPOSITS SHOULD BE REMOVED AFTER EACH STORM EVENT. FLOW RATE THEY MUST BE REMOVED WHEN DEPOSITS REACH APPROXIMATELY ASTM G-26 90% (MIN.) ULTRAVIOLET RADIATION ONE-HALF THE HEIGHT OF THE BARRIER. STABILITY % 5. ANY SEDIMENT DEPOSITS REMAINING IN PLACE AFTER THE SILT FENCE IS SEE DEHNR TABLE 6.62b NO LONGER REQUIRED SHALL BE DRESSED TO CONFORM WITH THE EXISTING GRADE, PREPARED AND SEEDED. 2. SYNTHETIC FILTER FABRIC SHALL CONTAIN ULTRAVIOLET RAY INHIBITORS AND STABILIZERS TO PROVIDE A MINIMUM OF 6 MONTHS OF EXPECTED USABLE CONSTRUCTION LIFE AT A TEMPERATURE RANGE OF 0°F TO 120°F. 3. IF WOODEN STAKES ARE UTILIZED FOR SILT FENCE CONSTRUCTION, THEY MUST HAVE A DIAMETER OF 2 INCHES WHEN OAK IS USED AND 4 INCHES WHEN PINE IS USED. WOODEN STAKES MUST HAVE A MINIMUM LENGTH OF 5 FEET. 4. IF STEEL POSTS (STANDARD "U" OR "T" SECTION) ARE UTILIZED FOR SILT FENCE CONSTRUCTION, THEY MUST HAVE A MINIMUM WEIGHT OF 1.33 POUNDS PER LINEAR FOOT AND SHALL HAVE A MINIMUM LENGTH OF 5 FEET AND SHALL HAVE PROJECTIONS FOR FASTENING FABRIC. 5. WIRE FENCE REINFORCEMENT FOR SILT FENCES USING STANDARD-STRENGTH FILTER CLOTH SHALL BE A MINIMUM 14 GAUGE AND SHALL HAVE A MAXIMUM MESH SPACING OF 6 INCHES.

1. THE HEIGHT OF A SILT FENCE SHALL BE A MINIMUM OF 16 INCHES. ABOVE THE ORIGINAL GROUND SURFACE AND SHALL NOT EXCEED 34 INCHES ABOVE GROUND

2. THE FILTER FABRIC SHALL BE PURCHASED IN A CONTINUOUS ROLL CUT TO THE

3. A TRENCH SHALL BE EXCAVATED APPROXIMATELY 4 INCHES WIDE AND 8 INCHES

DEEP ALONG THE LINE OF POSTS AND UPSLOPE SIDE OF THE PROPOSED

4. POSTS SHALL BE PLACED A MAXIMUM OF 6 FEET APART. THE FILTER FABRIC

SHALL BE FASTENED SECURELY TO THE UPSLOPE SIDE OF THE POSTS USING ONE INCH LONG (MINIMUM) HEAVY-DUTY WIRE STAPLES OR TIE WIRES AND

TWELVE INCHES OF FABRIC SHALL BE EXTENDED INTO THE TRENCH. THE FABRIC

UNAVOIDABLE, FILTER CLOTH SHALL BE SPLICED TOGETHER ONLY AT A SUPPORT

LENGTH OF THE BARRIER TO AVOID THE USE OF JOINTS. WHEN JOINTS ARE

POST, WITH A MINIMUM 6-FOOT OVERLAP, AND SECURELY SEALED.

5. THE 8 INCH BY 4 INCH TRENCH SHALL BE BACKFILLED AND THE SOIL


6. SILT FENCES SHALL BE REMOVED WHEN THEY HAVE SERVED THEIR USEFUL PURPOSE, BUT NOT BEFORE THE UPSLOPE AREA HAS BEEN PERMANENTLY


LOCATION OF THE MEASURE.


STABILIZED.

SHALL NOT BE STAPLED TO EXISTING TREES.

COMPACTED OVER THE FILTER FABRIC.

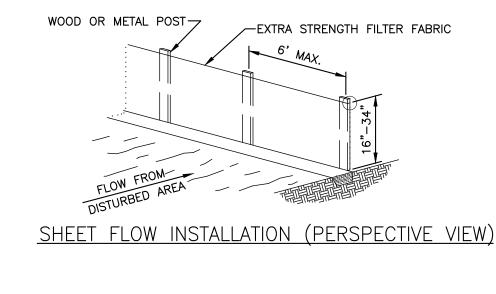


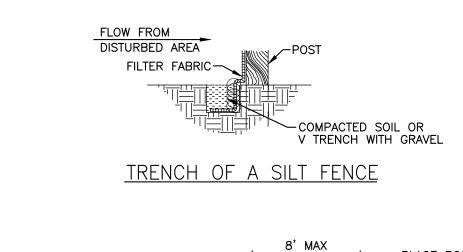


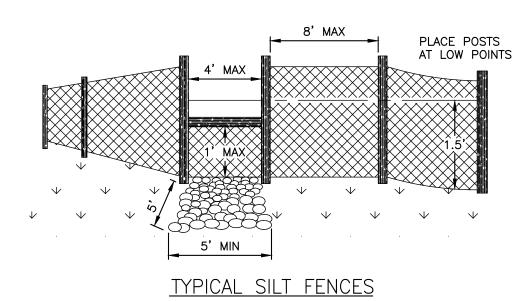

TEMPORARY SILT FENCE

TEMPORARY ROCK SILT CHECK DAM

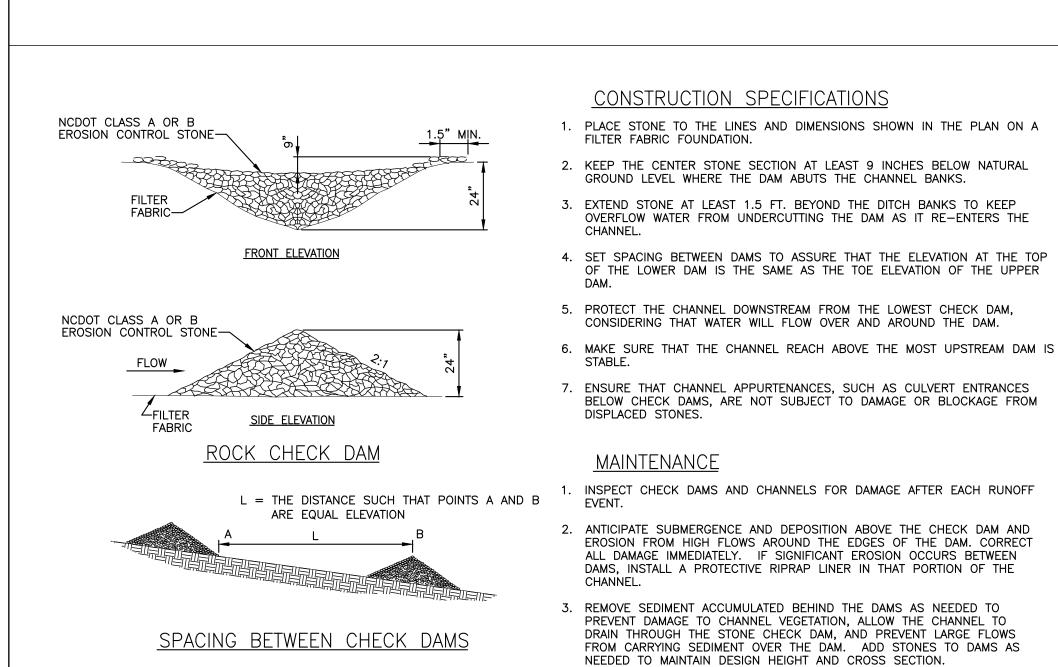

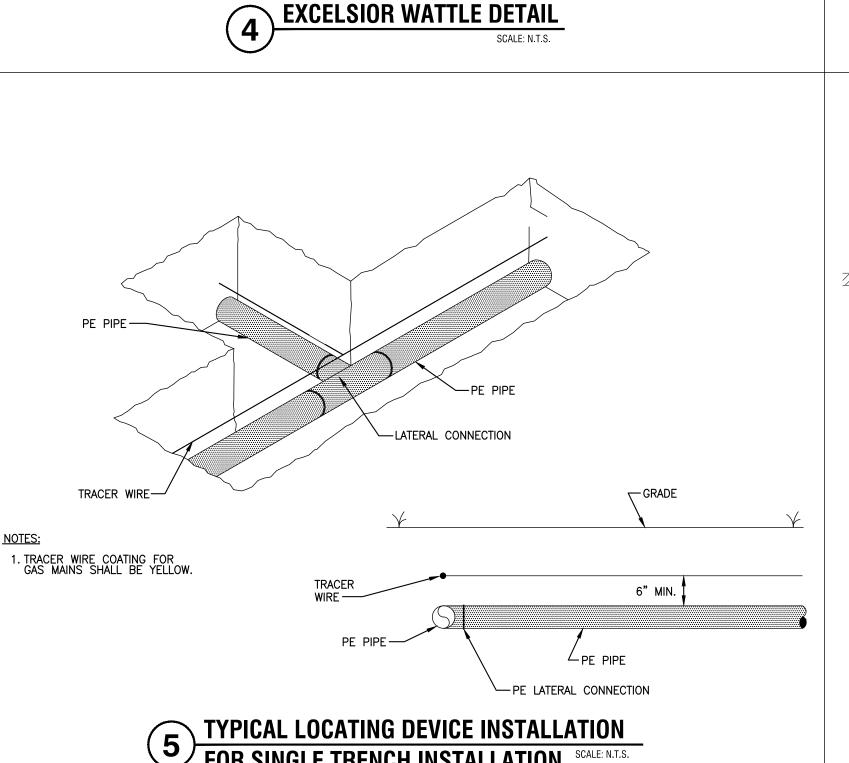

- NATURAL GROUND

CONSTRUCTION SPECIFICATIONS

METAL WITH A MINIMUM LENGTH OF 3 FEET.

GROUND, APPROXIMATELY 18-INCHES DEEP.

CONTINUOUS ROLL TO AVOID JOINTS.

A. SILT FENCE SHALL CONFORM TO THE CONSTRUCTION SPECIFICATIONS

B. STAKES SHALL BE 2 x 4-INCH WOOD (PREFERRED) OR EQUIVALENT

C. SPACE STAKES EVENLY AROUND THE PERIMETER OF THE INLET A

MAXIMUM OF 1 1/2 FEET ABOVE THE DROP INLET CREST.

MAXIMUM OF 3-FEET APART, AND SECURELY DRIVE THEM INTO THE

D. TO PROVIDE NEEDED STABILITY TO THE INSTALLATION, FRAME WITH 2 x

E. PLACE THE BOTTOM 12 INCHES OF THE FABRIC IN A TRENCH AND

F. FASTEN FABRIC SECURELY BY STAPLES OR WIRE TO THE STAKES AND

BACKFILL THE TRENCH WITH 12 INCHES OF COMPACTED SOIL.

FRAME. JOINTS MUST BE OVERLAPPED TO THE NEXT STAKE.

DOWNSLOPE SIDE OF THE STRUCTURE TO PREVENT BYPASS FLOW.

G. IT MAY BE NECESSARY TO BUILD A TEMPORARY DIKE ON THE

4-INCH WOOD STRIPS AROUND THE CREST OF THE OVERFLOW AREA AT A

FOR "EXTRA STRENGTH" DEHNR 6.51 AND SHALL BE CUT FROM A

1. SILT FENCE DROP INLET PROTECTION

WOOD FRAME

STAKE-

FABRIC-

RUNOFF WATER

WITH SEDIMENT

USE MINIMUM 12 IN. DIAMETER EXCELSIOR WATTLE.

USE 2 FT. WOODEN STAKES WITH A 2 IN. BY 2 IN. NOMINAL CROSS SECTION.

ONLY INSTALL WATTLE(S) TO A HEIGHT IN DITCH SO FLOW WILL NOT WASH AROUND WATTLE AND SCOUR DITCH SLOPES AND AS DIRECTED.

INSTALL A MINIMUM OF 2 UPSLOPE STAKES AND 4 DOWNSLOPE STAKES AT AN ANGLE

PROVIDE STAPLES MADE OF 0.125 IN. DIAMETER STEEL WIRE FORMED INTO A "U" SHAPE NOT LESS THAN 12" IN LENGTH.


INSTALL MATTING IN ACCORDANCE WITH SECTION 1631 OF THE STANDARD SPECIFICATIONS.

INSTALL STAPLES APPROXIMATELY EVERY 1 LINEAR FOOT ON BOTH SIDES OF WATTLE AND AT EACH END TO SECURE IT TO THE SOIL.


WITH GRATE


→GATHER EXCESS

FILTERED WATER

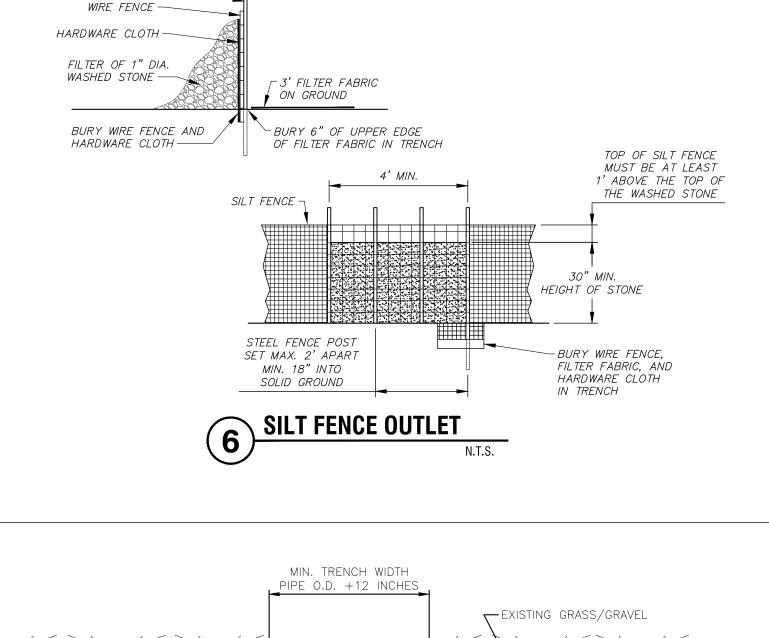

STEEL FENCE POST —

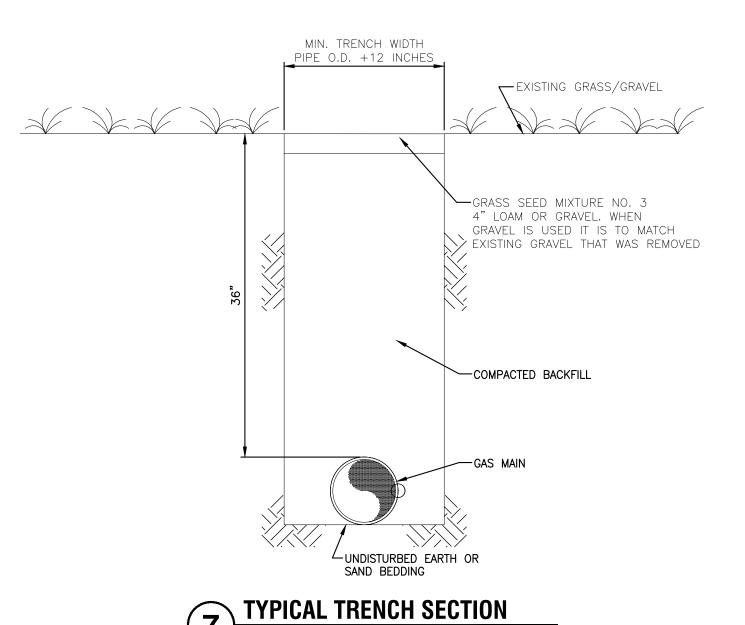

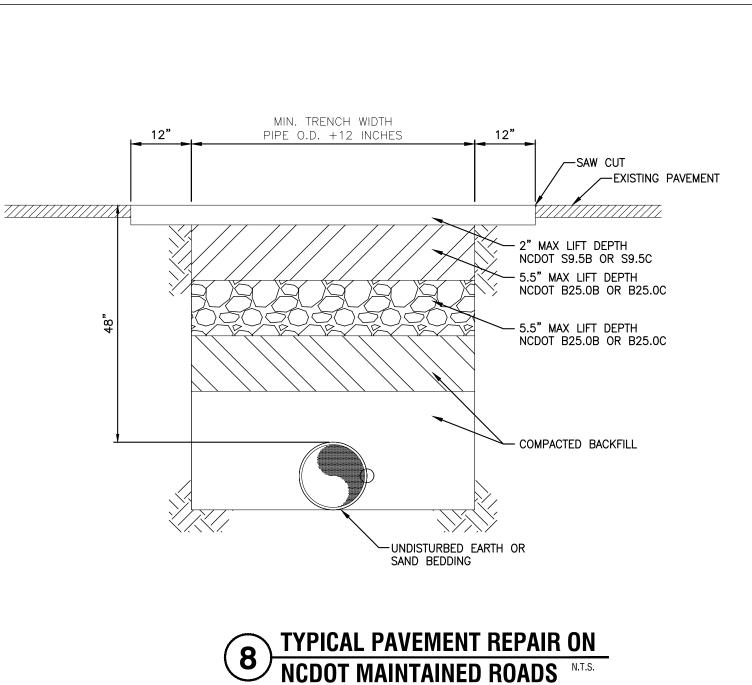



REVISIONS:

CHOOL

S F

HIGH S

NON

S

Ш

ELLANI

AND



Sheet No. 6

